


THIS EXHIBIT IS PREPARED FOR SITE PLAN REVIEW PURPOSES ONLY. THE CUT AND FILL INFORMATION REFLECTED HEREIN IS BASED UPON AN EXISTING TO PROPOSED SURFACE COMPARISON.

GRADING/UTILITY GRAPHIC LEGEND

---	PROPERTY LINE (HARSH IN QUESTION)	---	EXIST. CABLE LINE	---	PROF. CABLE LINE
---	OFF-SITE PROPERTY LINES	---	EXIST. ELECTRIC LINE	---	PROF. ELECTRIC LINE
---		---	EXIST. FIBER OPTIC LINE	---	PROF. FIBER OPTIC LINE
---		---	EXIST. GAS LINE	---	PROF. GAS LINE
---		---	EXIST. OVERHEAD WIRES	---	PROF. OVERHEAD WIRES
---		---	EXIST. TELEPHONE LINE	---	PROF. TELEPHONE LINE
---		---	EXIST. UNDERGROUND ELEC./TELE. SERVICE (NO. & SIZE OF CONDUITS NOT SHOWN)	---	PROF. UNDERGROUND ELEC./TELE. SERVICE (NO. & SIZE OF CONDUITS NOT SHOWN)
---		---	EXIST. WATER LINE	---	PROF. WATER LINE
---		---	EXIST. SANITARY SEWER LINE	---	PROF. SANITARY SEWER LINE
---		---	EXIST. STORM DRAIN LINE	---	PROF. STORM DRAIN LINE
---		---	EXIST. MINOR CONTOUR & ELEVATION	---	PROF. FINISH GRADE CONTOUR & ELEVATION
---		---	EXIST. MAJOR CONTOUR & ELEVATION	---	PROF. FINISH GRADE CONTOUR & ELEVATION
---		---	EXIST. MONITORING WELL	---	PROF. MONITORING WELL
---		---	APPROX. TEST PIT LOCATION	---	PROF. TEST PIT LOCATION
---		---	EXIST. SPOT ELEVATIONS	---	PROF. SPOT ELEVATIONS
---		---	EXIST. CUTTER ELEV.	---	PROF. CUTTER ELEV.
---		---	EXIST. TOP OF CURB ELEV.	---	PROF. TOP OF CURB & FINISHED GRADE ELEV.
---		---	EXIST. FINISH FLOOR ELEV.	---	PROF. FINISH FLOOR ELEV.
---		---	EXIST. GARAGE FLOOR ELEV.	---	PROF. GARAGE FLOOR ELEV.
---		---	EXIST. FIRE HYDRANT	---	PROF. FIRE HYDRANT
---		---	EXIST. WATER VALVE	---	PROF. WATER VALVE
---		---	EXIST. GAS VALVE	---	PROF. GAS VALVE
---		---	EXIST. GAS METER	---	PROF. GAS METER
---		---	EXIST. ELECTRIC METER	---	PROF. ELECTRIC METER
---		---	EXIST. ELECTRIC BOX	---	PROF. ELECTRIC BOX
---		---	EXIST. CLEAN OUT	---	PROF. CLEAN OUT
---		---	EXIST. WELL	---	PROF. WELL
---		---	EXIST. WATER SHUT OFF VALVE	---	PROF. WATER SHUT OFF VALVE
---		---	EXIST. TELEPHONE BOX	---	PROF. TELEPHONE BOX
---		---	EXIST. CABLE TV BOX	---	PROF. CABLE TV BOX
---		---	EXIST. UTILITY POLE	---	PROF. UTILITY POLE
---		---	EXIST. GUY WIRE	---	PROF. GUY WIRE
---		---	EXIST. LIGHT POLE	---	PROF. LIGHT POLE
---		---	EXIST. BUILDING LIGHT	---	PROF. BUILDING LIGHT
---		---	EXIST. STREET LIGHT	---	PROF. STREET LIGHT
---		---	EXIST. CURBS LIGHT POLE	---	PROF. CURBS LIGHT POLE
---		---	EXIST. TRAFFIC SIGNAL POLE	---	PROF. TRAFFIC SIGNAL POLE
---		---	EXIST. MANHOLE	---	PROF. MANHOLE
---		---	EXIST. 'A' INLET	---	PROF. 'A' INLET
---		---	EXIST. 'B' INLET	---	PROF. 'B' INLET
---		---	EXIST. 'C' INLET	---	PROF. 'C' INLET
---		---	EXIST. 'D' INLET	---	PROF. 'D' INLET
---		---	EXIST. 'E' INLET	---	PROF. 'E' INLET
---		---	EXIST. 'F' INLET	---	PROF. 'F' INLET
---		---	EXIST. 'G' INLET	---	PROF. 'G' INLET
---		---	EXIST. 'H' INLET	---	PROF. 'H' INLET
---		---	EXIST. 'I' INLET	---	PROF. 'I' INLET
---		---	EXIST. 'J' INLET	---	PROF. 'J' INLET
---		---	EXIST. 'K' INLET	---	PROF. 'K' INLET
---		---	EXIST. 'L' INLET	---	PROF. 'L' INLET
---		---	EXIST. 'M' INLET	---	PROF. 'M' INLET
---		---	EXIST. 'N' INLET	---	PROF. 'N' INLET
---		---	EXIST. 'O' INLET	---	PROF. 'O' INLET
---		---	EXIST. 'P' INLET	---	PROF. 'P' INLET
---		---	EXIST. 'Q' INLET	---	PROF. 'Q' INLET
---		---	EXIST. 'R' INLET	---	PROF. 'R' INLET
---		---	EXIST. 'S' INLET	---	PROF. 'S' INLET
---		---	EXIST. 'T' INLET	---	PROF. 'T' INLET
---		---	EXIST. 'U' INLET	---	PROF. 'U' INLET
---		---	EXIST. 'V' INLET	---	PROF. 'V' INLET
---		---	EXIST. 'W' INLET	---	PROF. 'W' INLET
---		---	EXIST. 'X' INLET	---	PROF. 'X' INLET
---		---	EXIST. 'Y' INLET	---	PROF. 'Y' INLET
---		---	EXIST. 'Z' INLET	---	PROF. 'Z' INLET

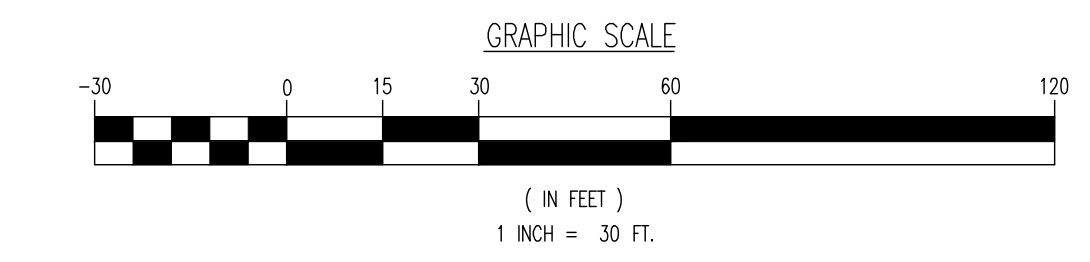

Cut/Fill Summary

Name	Cut Factor	Fill Factor	2d Area	Cut	Fill	Net
CUT-FILL 1.000	1.000		214041.41 Sq. Ft.	2074.26 Cu. Yd.	15258.29 Cu. Yd.	13184.03 Cu. Yd.<Fill>
Totals			214041.41 Sq. Ft.	2074.26 Cu. Yd.	15258.29 Cu. Yd.	13184.03 Cu. Yd.<Fill>

Elevations Table

Number	Minimum Elevation	Maximum Elevation	Color	AREA
1	-4.093	0.000	Red	68.817.06
2	0.000	6.943	Green	145224.35

Project: 11/20/23 - 8:33 AM, By: dgh, Product Ver: 24.2a (US Int), Path: \\us01\projects\2023\11-20-23\11-20-23.dwg, Date: 11/20/23 8:33 AM, Project: 11/20/23 - 8:33 AM, By: dgh, Product Ver: 24.2a (US Int), Path: \\us01\projects\2023\11-20-23\11-20-23.dwg, Date: 11/20/23 8:33 AM

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TITLE: EARTHWORK EXHIBIT

PROJECT: ARNY ASSOCIATES, LLC
 PROPOSED WAREHOUSE REDEVELOPMENT
 BLOCK 8, LOTS 1.02 & 1.03
 322 & 326 CRANBURY HALF ACRE ROAD
 TOWNSHIP OF CRANBURY, MIDDLESEX COUNTY, NEW JERSEY

JOB No: 3529-99-001 DATE: 11/28/2023
 DRAWN BY: DJB SCALE: (H) 1"=30'
 DESIGNED BY: CTD (V)
 CHECKED BY: JEH SHEET No: 1
 CHECKED BY: JEH OF 1

JAMES E. HENRY PROFESSIONAL ENGINEER
 NEW JERSEY LICENSE No. 49266

JOSHUA M. SEWALD PROFESSIONAL ENGINEER
 NEW JERSEY LICENSE No. 52908

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